

GRADY HEALTH SYSTEM

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CONSTRUCTION

[illegible]

SHEET TITLE

GENERAL  
NOTES

SHEET NUMBER

S-001

12/16/2022 10:30:20 AM

A	—	B	—	C	—	D	—	E	—	F	—	G	—	H	—	J	—	K	—	L	—	M	—	N	—	P	—
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	1704	
	1705	
	1705	
	1705	
	1705	C
	1705	f

[illegible][illegible]

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**SHEAR**  
STRUCTURAL  
931 MONROE DR  
SUITE A100  
ATLANTA, GA 30317  
(678) 664-1000  
SHEARSTRUCTURAL.COM

GRADY HEALTH SYSTEM  
STORIEA URGENT CARE  
Corner of Memorial Drive & Estoria Street  
Atlanta, GA 30316

PROJECT NO:		25132.00
DD	DD PACKAGE	12/18/25

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SHEET TITLE


**SPECIAL  
INSPECTIONS**


SHEET NUMBER

S-004

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SHEET TITLE  
FOUNDATION  
PLAN




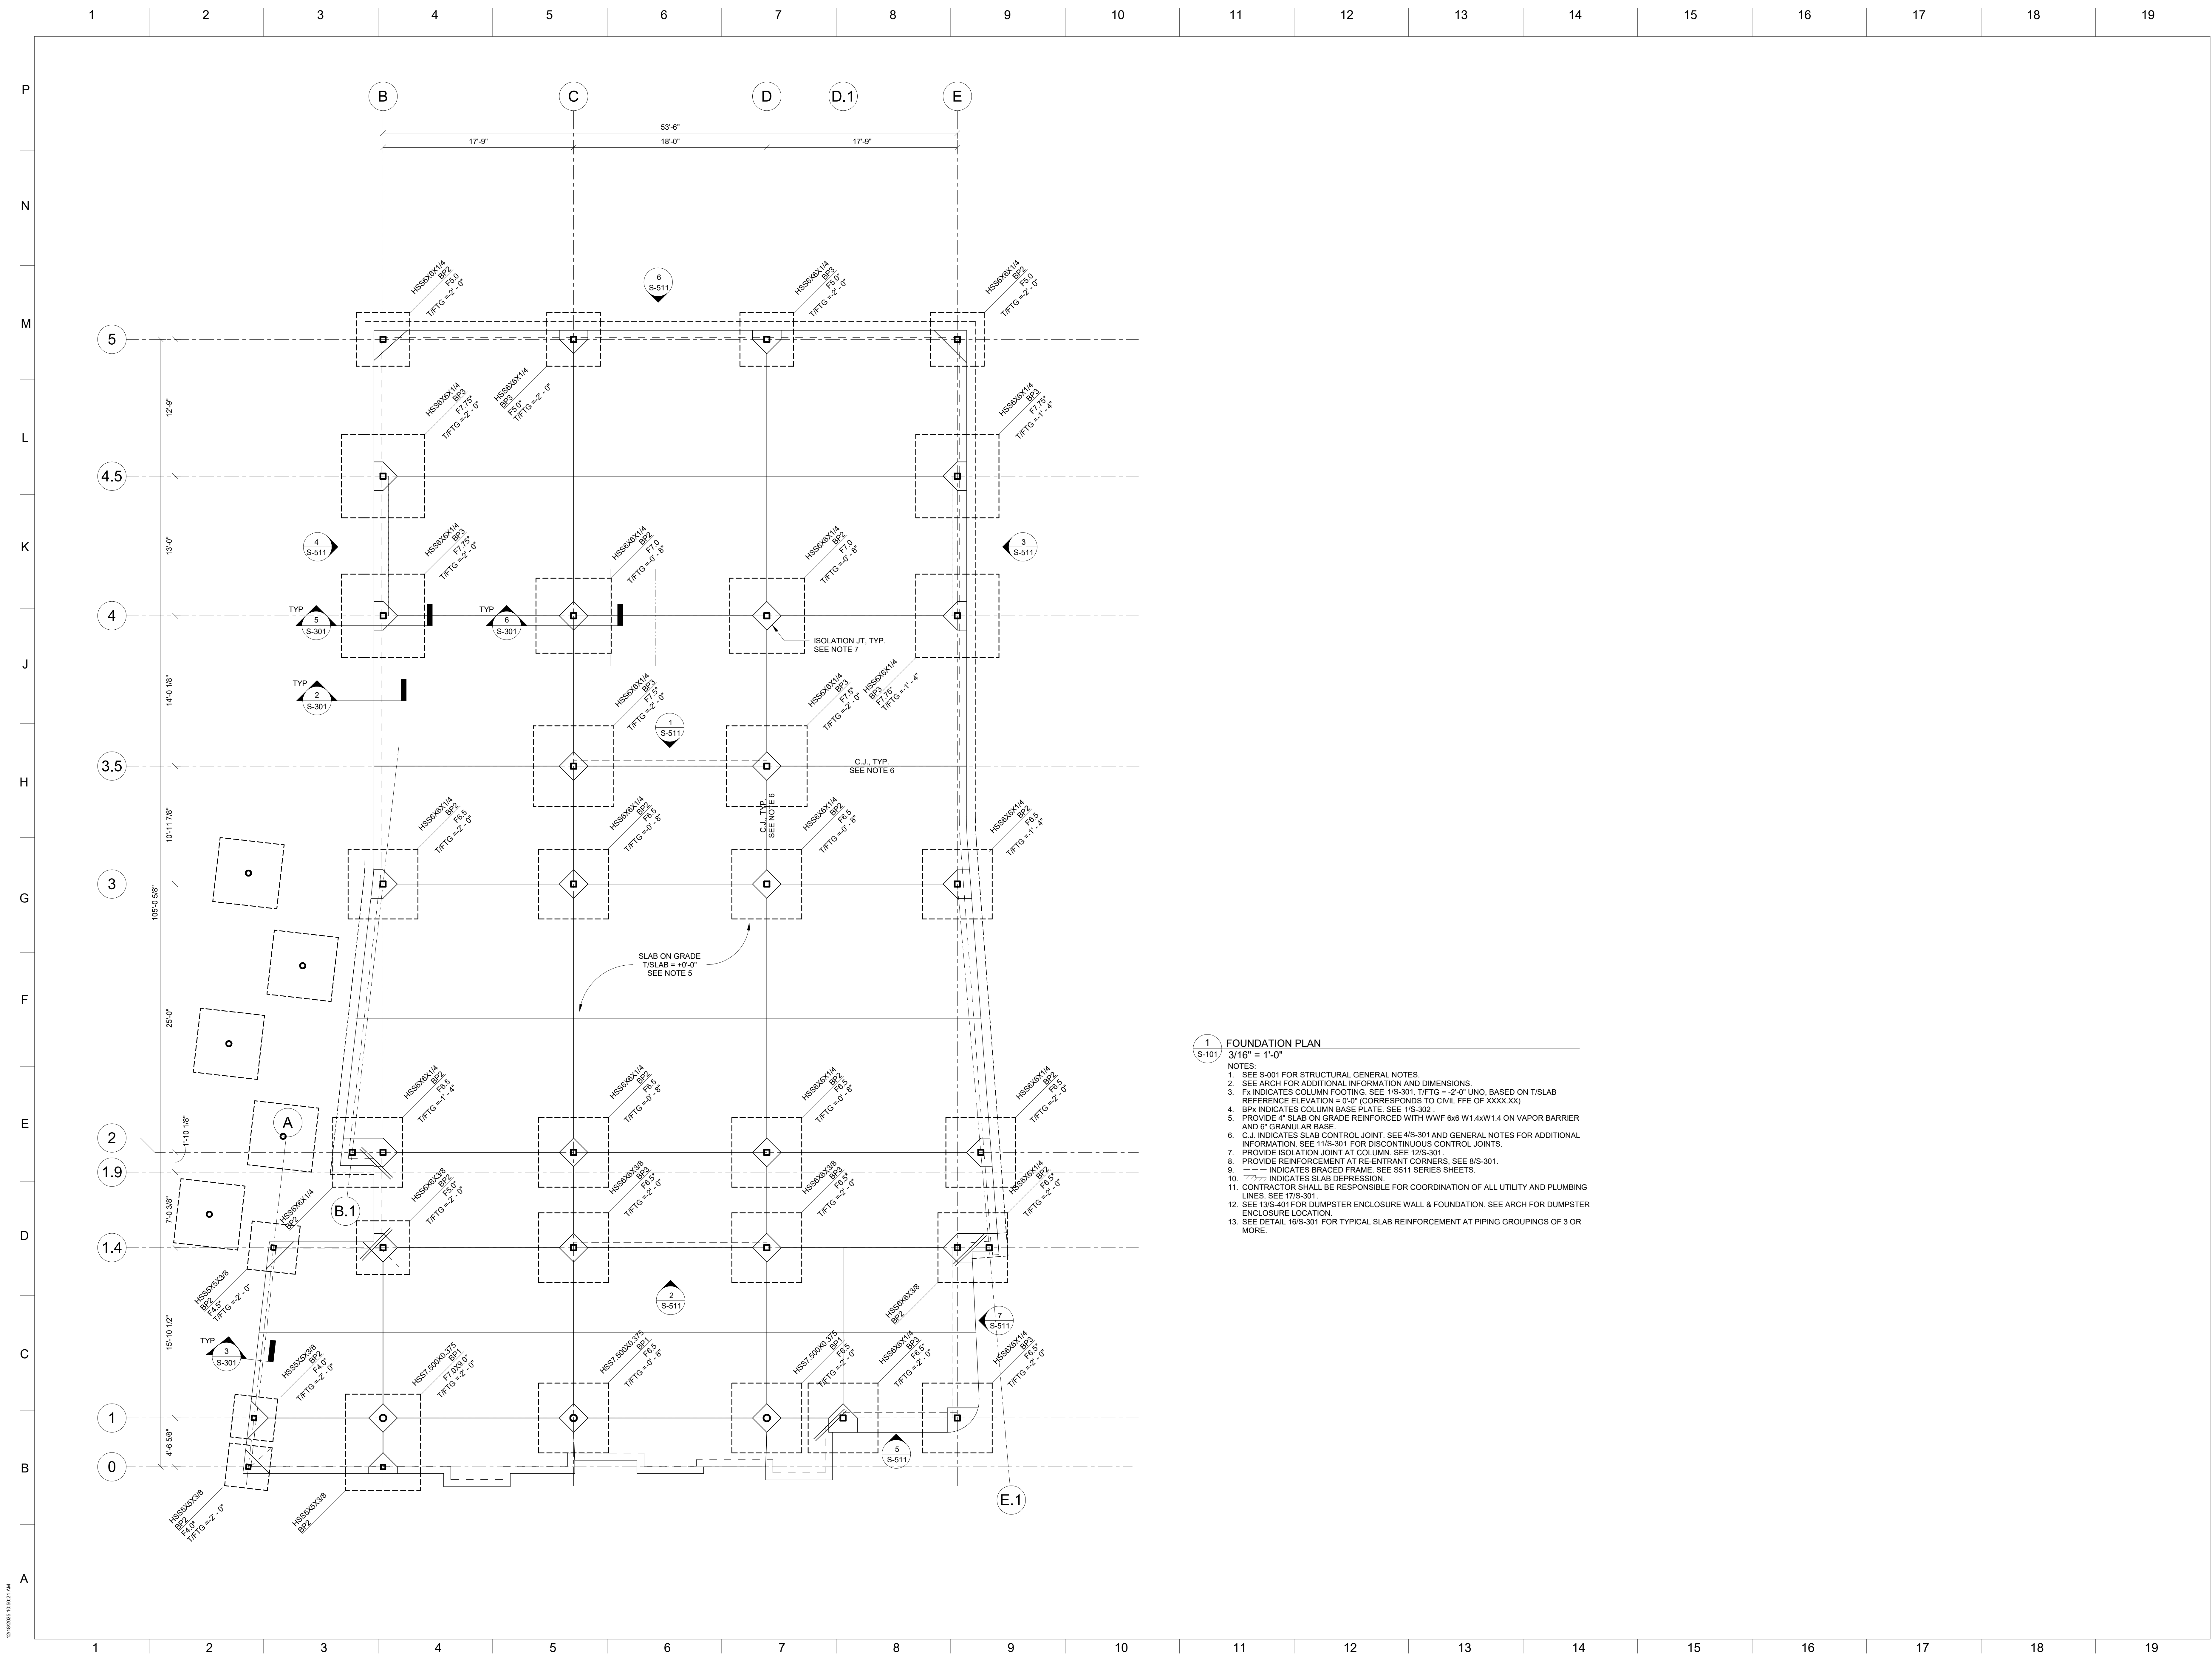

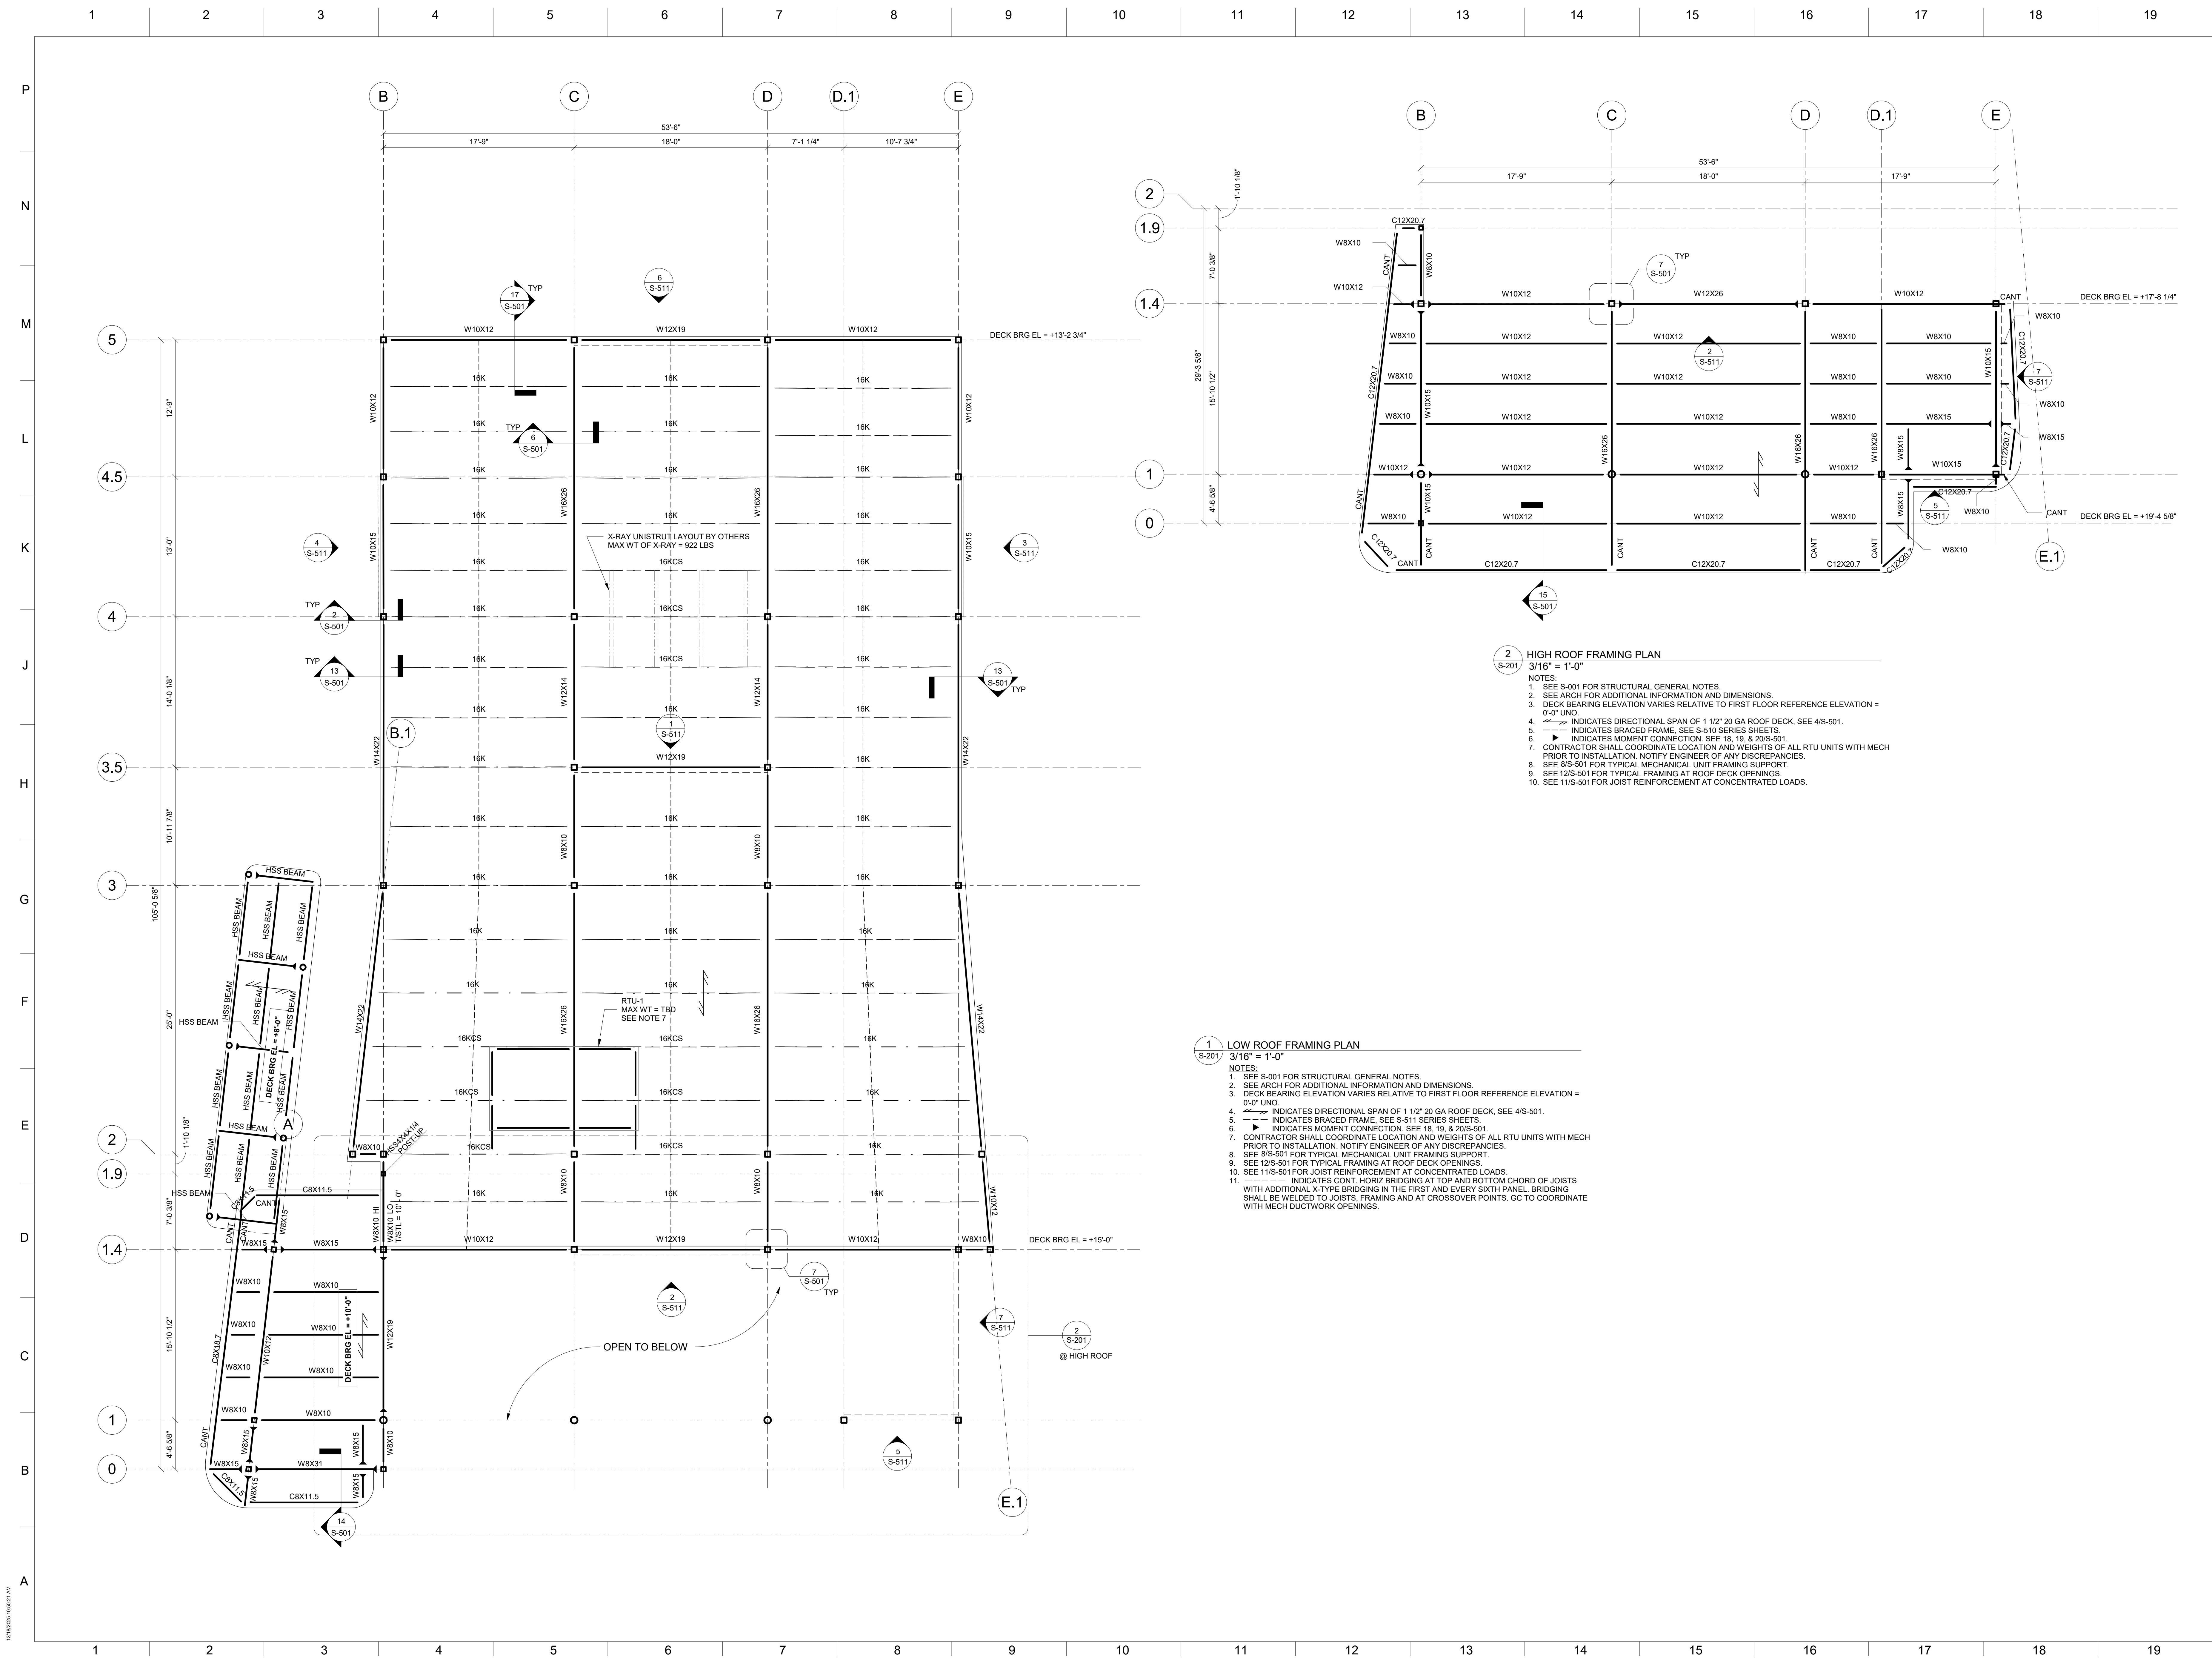

BASE PLATE AND ANCHOR BOLT SCHEDULE									
COLUMN SIZE	BASE PLATE					ANCHOR BOLTS			WELD
	A	B	C	D1	D2	E	F	NO	W
BP1	3/4"	1'-2"	1'-2"	5 1/2"	5 1/2"	3/4"	9"	4	3/16"
BP2	3/4"	1'-0"	1'-0"	4 1/2"	4 1/2"	3/4"	9"	4	3/16"
BP3	3/4"	1'-0"	1'-0"	4 1/2"	4 1/2"	3/4"	12"	4	3/16"

NOTES:  
1. PLATE LENGTHS MAY VARY @ BRACED FRAME COLUMN LOCATIONS DUE TO GUSSET PLATE.

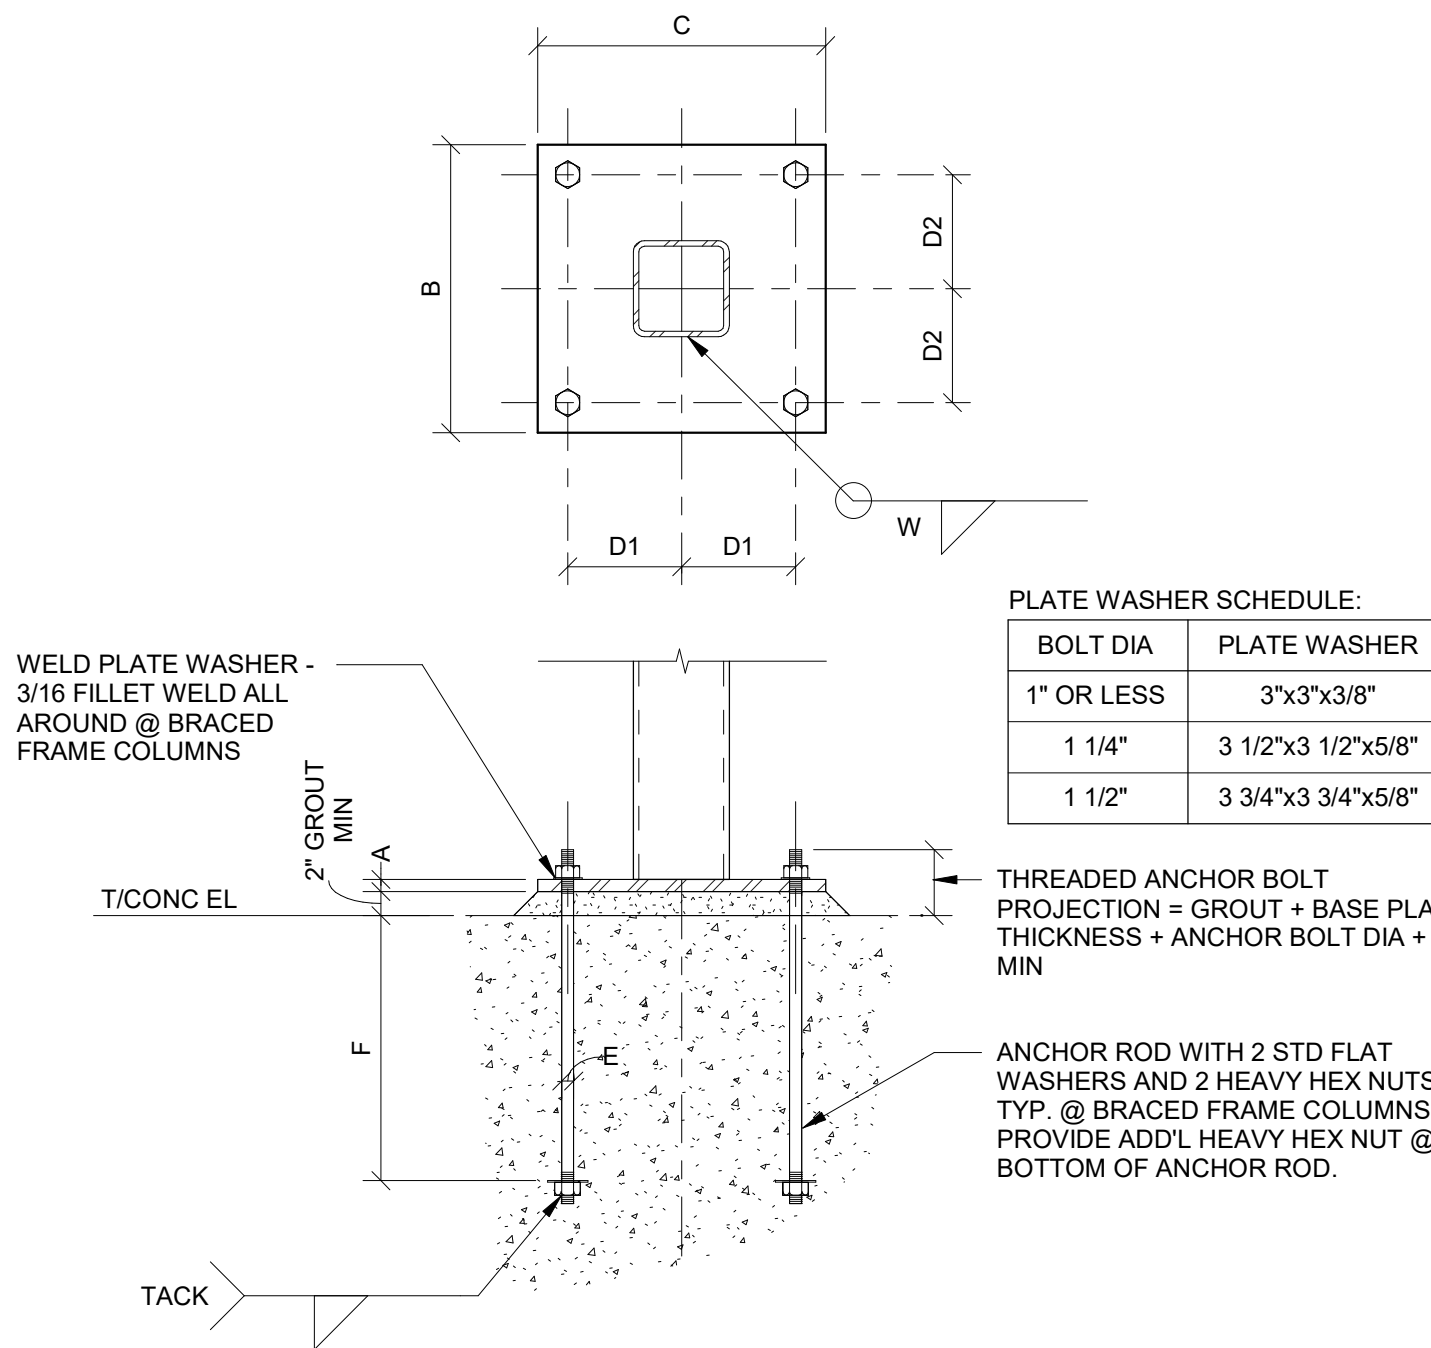

1	TYPICAL BASE PLATE AND ANCHOR BOLT (TUBE)
S-302	3/4" = 1'-0"

PROJECT NO:	25132.00
DD PACKAGE	12/18/25

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* MASONRY REINFORCING LAP SCHEDULE	
	8" CMU
BAR SIZE	CENTERED
#3	20"
#4	26"
#5	32"
#6	39"

FILL ALL CELLS SOLID W/  
GROUT THAT REQUIRE  
VERT REINF AND ALL  
CELLS BELOW GRADE

**NOTES:**



1. USE 5'-4" MAXIMUM LIFTS
2. FOR FOOTING AND ADDITIONAL REINFORCING, REFER TO PLANS AND SECTIONS

SHEET TITLE


## MASONRY DETAILS

SHEET NUMBER


# S-401

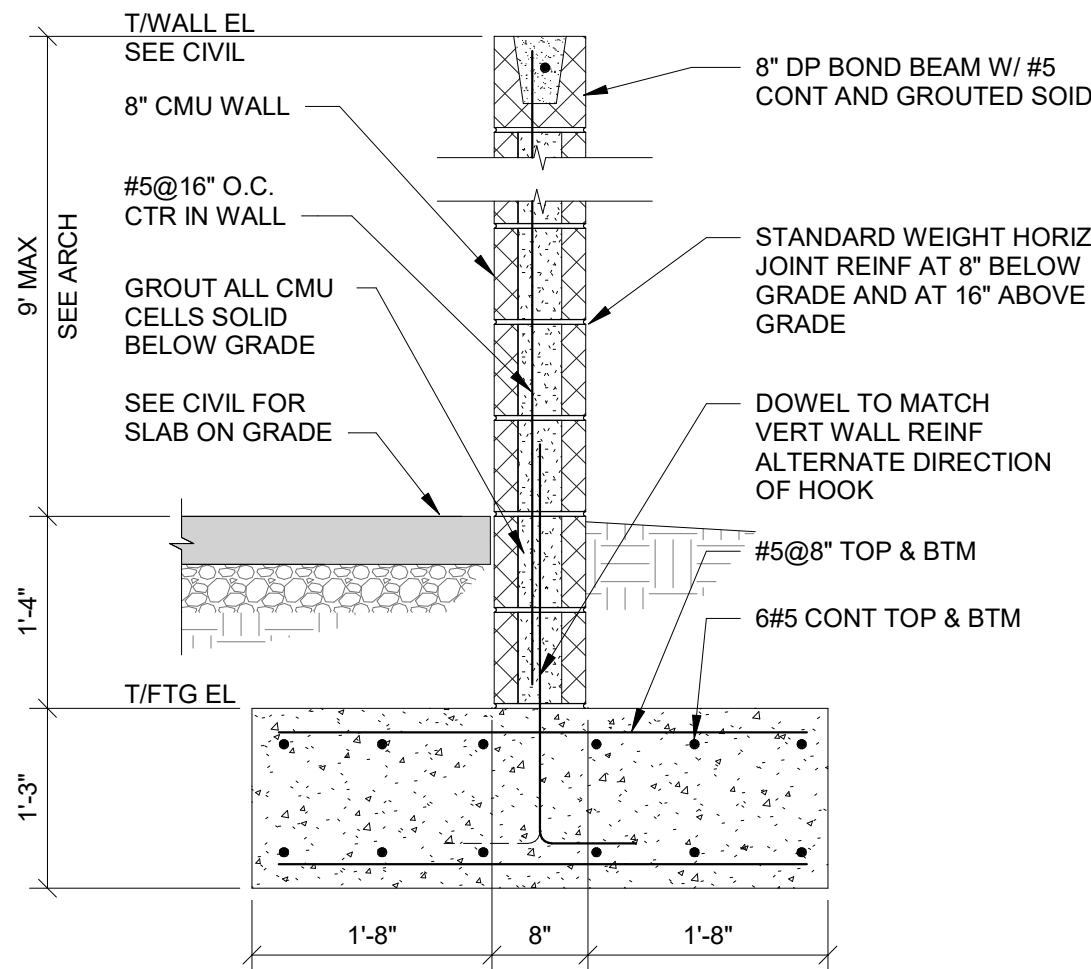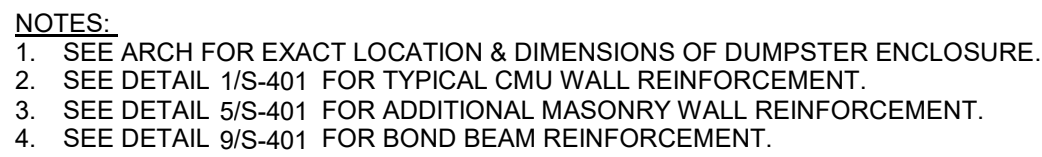


13 TYPICAL DUMPSTER SCREEN WALL SECTION  
S-401 3/4" = 1'-0"

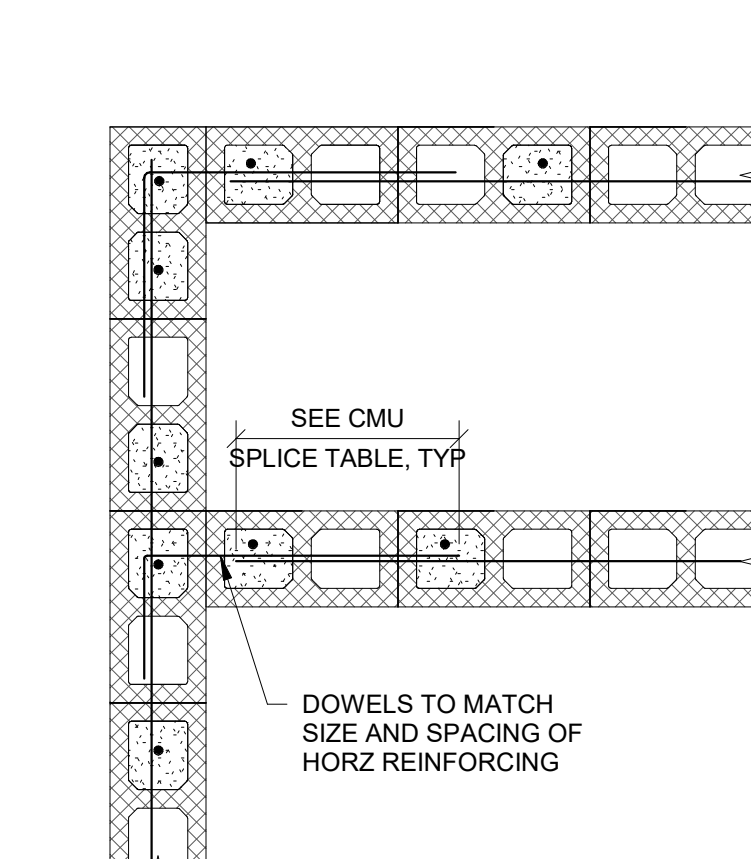

### SINGLE LAYER REINFORCING

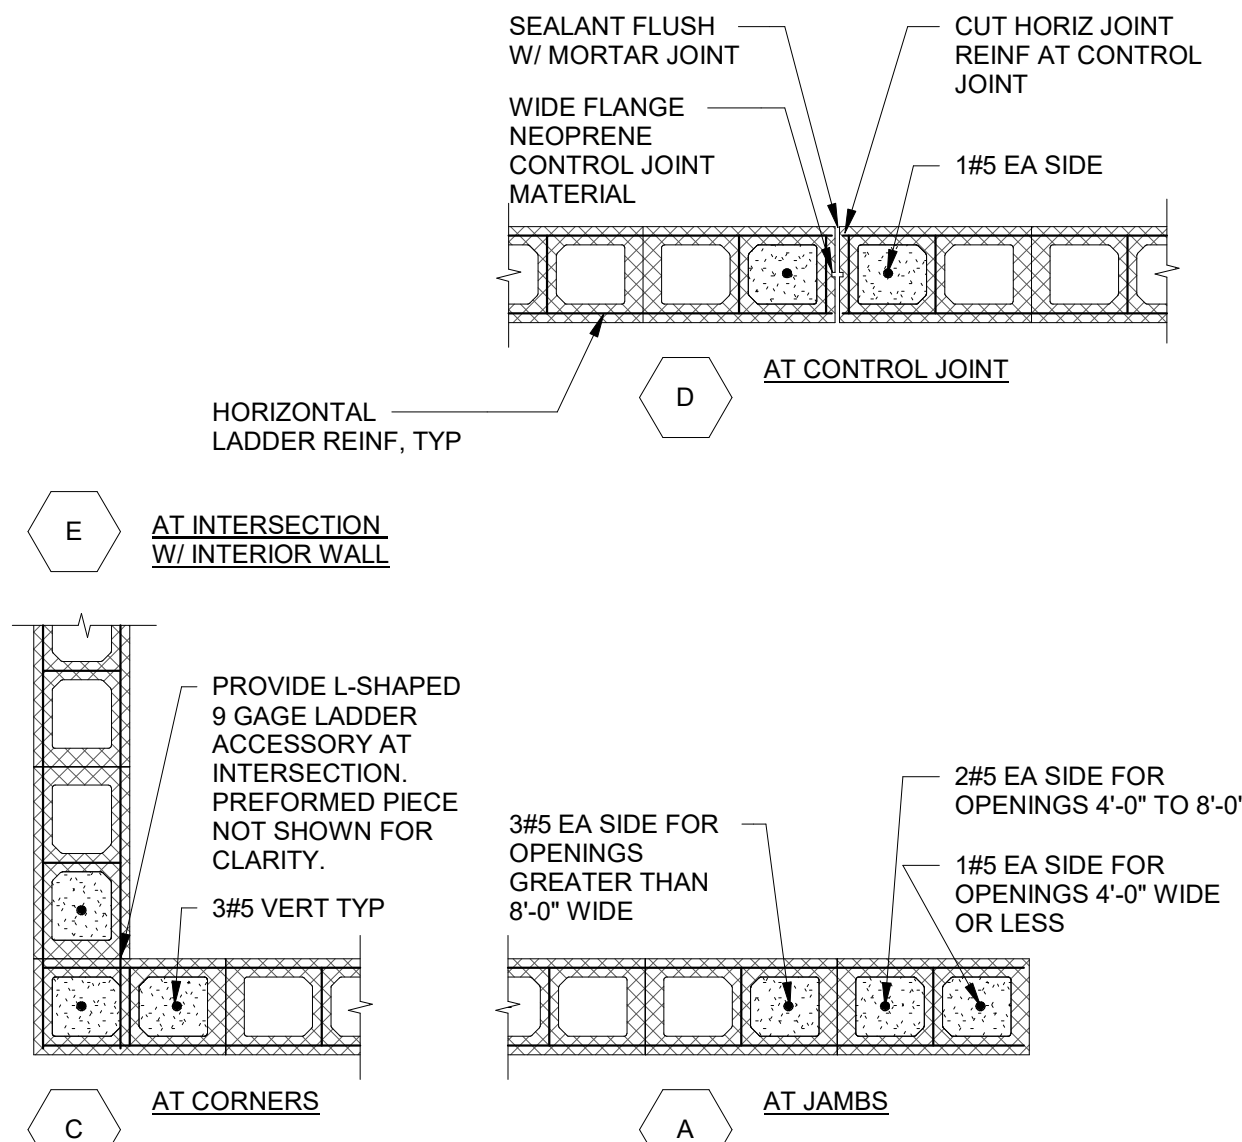

TYPICAL REINFORCING AT 8" LOAD BEARING CMU WALL  
3/4" = 1'-0"

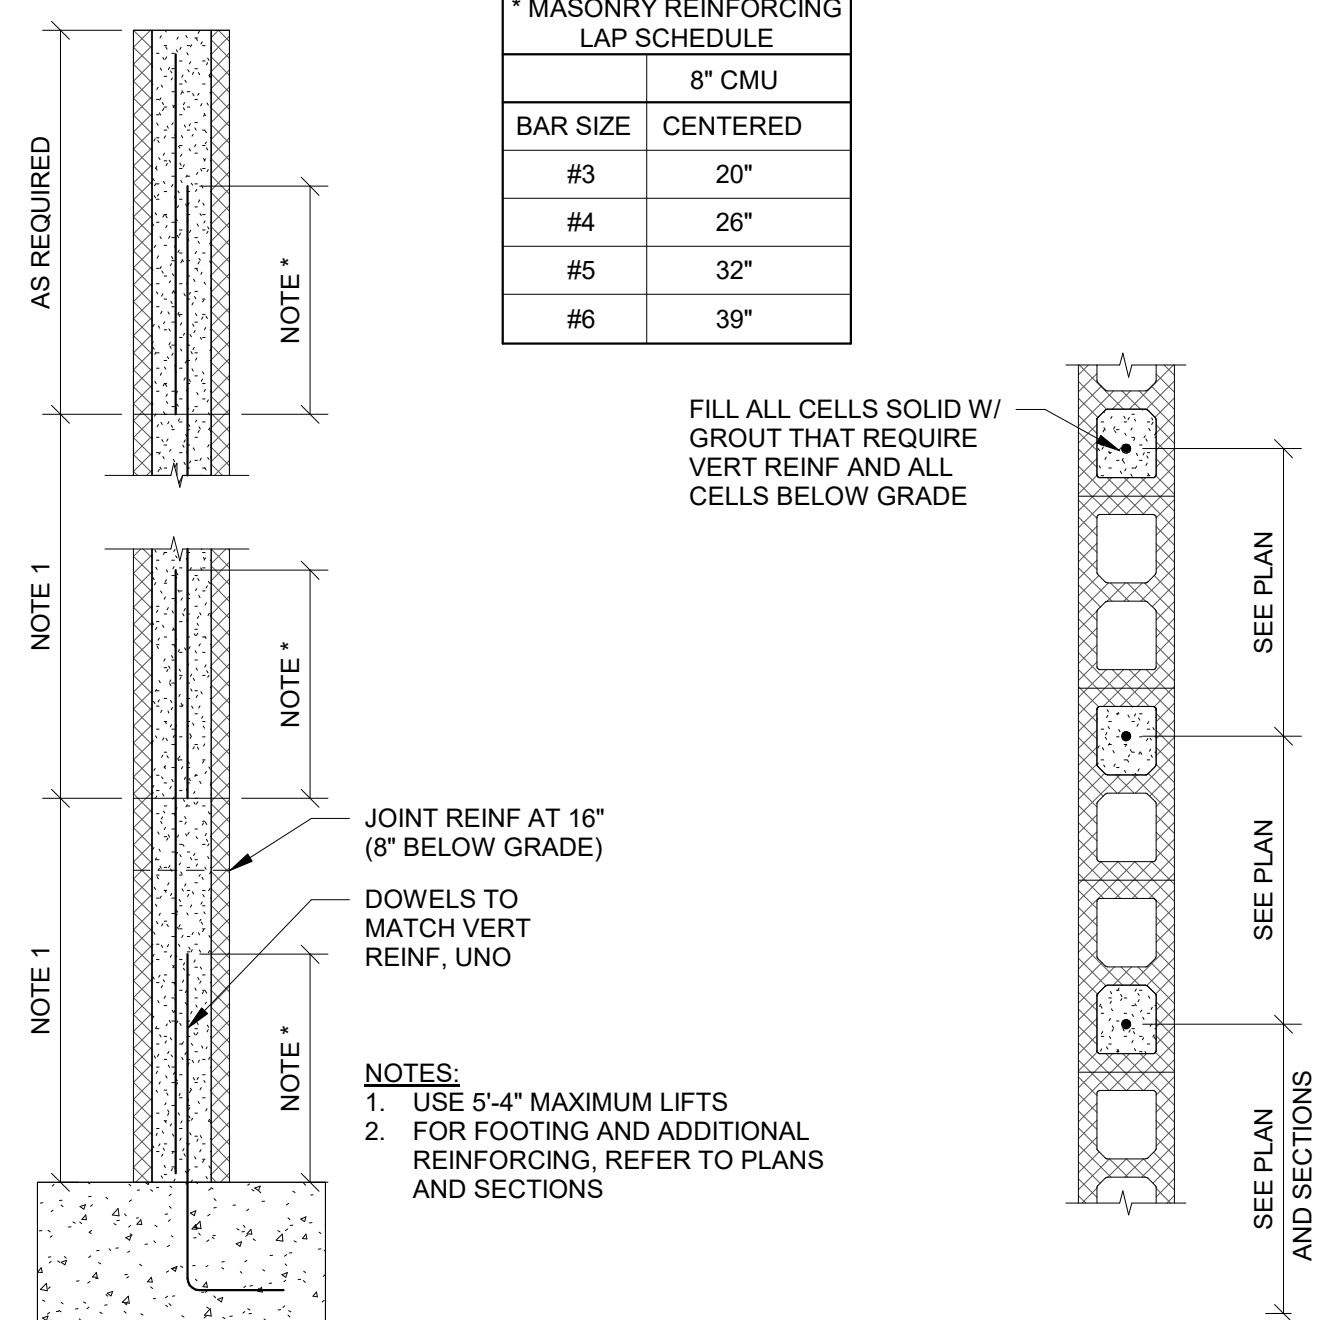

1 TYPICAL REINFORCED CMU WALL  
S-401 3/4" = 1'-0"



## GRADY HEALTH SYSTEM


College of Memorial Drive & Estofia Street  
Atlanta, GA 30316

1. ALL BRACED FRAME CONNECTIONS SHALL BE DESIGNED BY STEEL FABRICATOR.
2. ALL BRACED FRAME CONNECTIONS SHALL BE DESIGNED FOR AXIAL TENSION, AXIAL COMPRESSION AND SHEAR FORCES SHOWN.
3. "K" INDICATES AXIAL TENSION AND COMPRESSION FORCE IN KIPS (SERVICE) IN THE MEMBER.
4. "V" INDICATES SHEAR FORCE (SERVICE) IN BEAM MEMBER. IF SHEAR FORCE IS NOT INDICATED, DESIGN FORCE SHALL BE OBTAINED BY TABLES ENTITLED MAXIMUM TOTAL UNIFORM LOAD IN PART 3 OF THE AISC MANUAL OF STEEL CONSTRUCTION, FIFTH EDITION. DESIGN REACTION IS EQUAL TO HALF TABULATED VALUE OF NON-COMPOSITE BEAMS AND EQUAL TO THE TABULATED VALUE OF COMPOSITE BEAMS.
5. SEE PLAN FOR T/S1, ELEVATIONS. SEE PLAN FOR MEMBER SIZES NOT SHOWN.


S-50



S-502

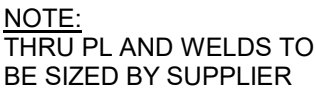

S-502

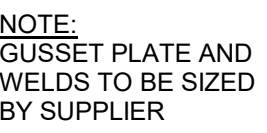

S-502

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SHEET TITLE

# S-502

